


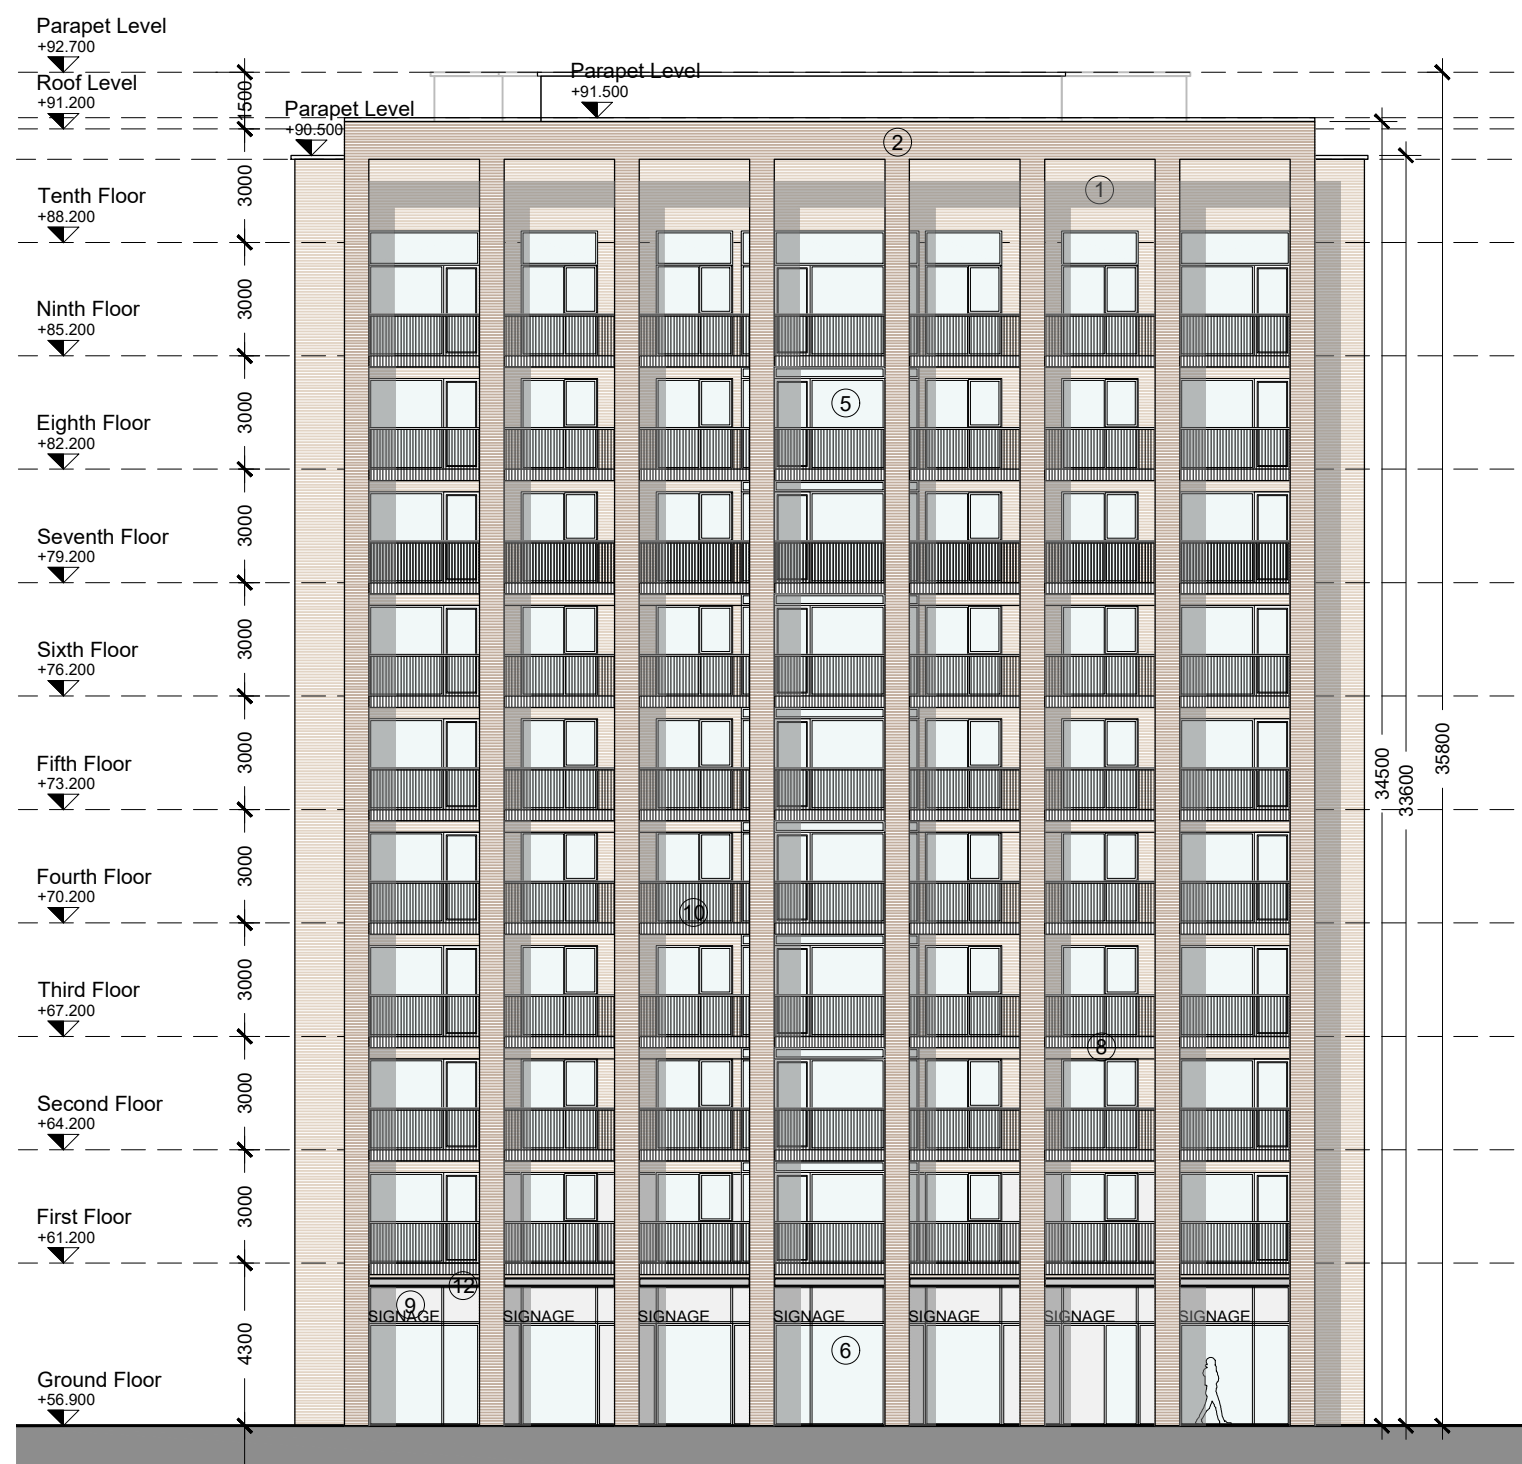


01 NORTH ELEVATION
P4000 SCALE 1:200 @A1




02 WEST ELEVATION
P4000 SCALE 1:200 @A1



03 SOUTH ELEVATION
P4000 SCALE 1:200 @A1

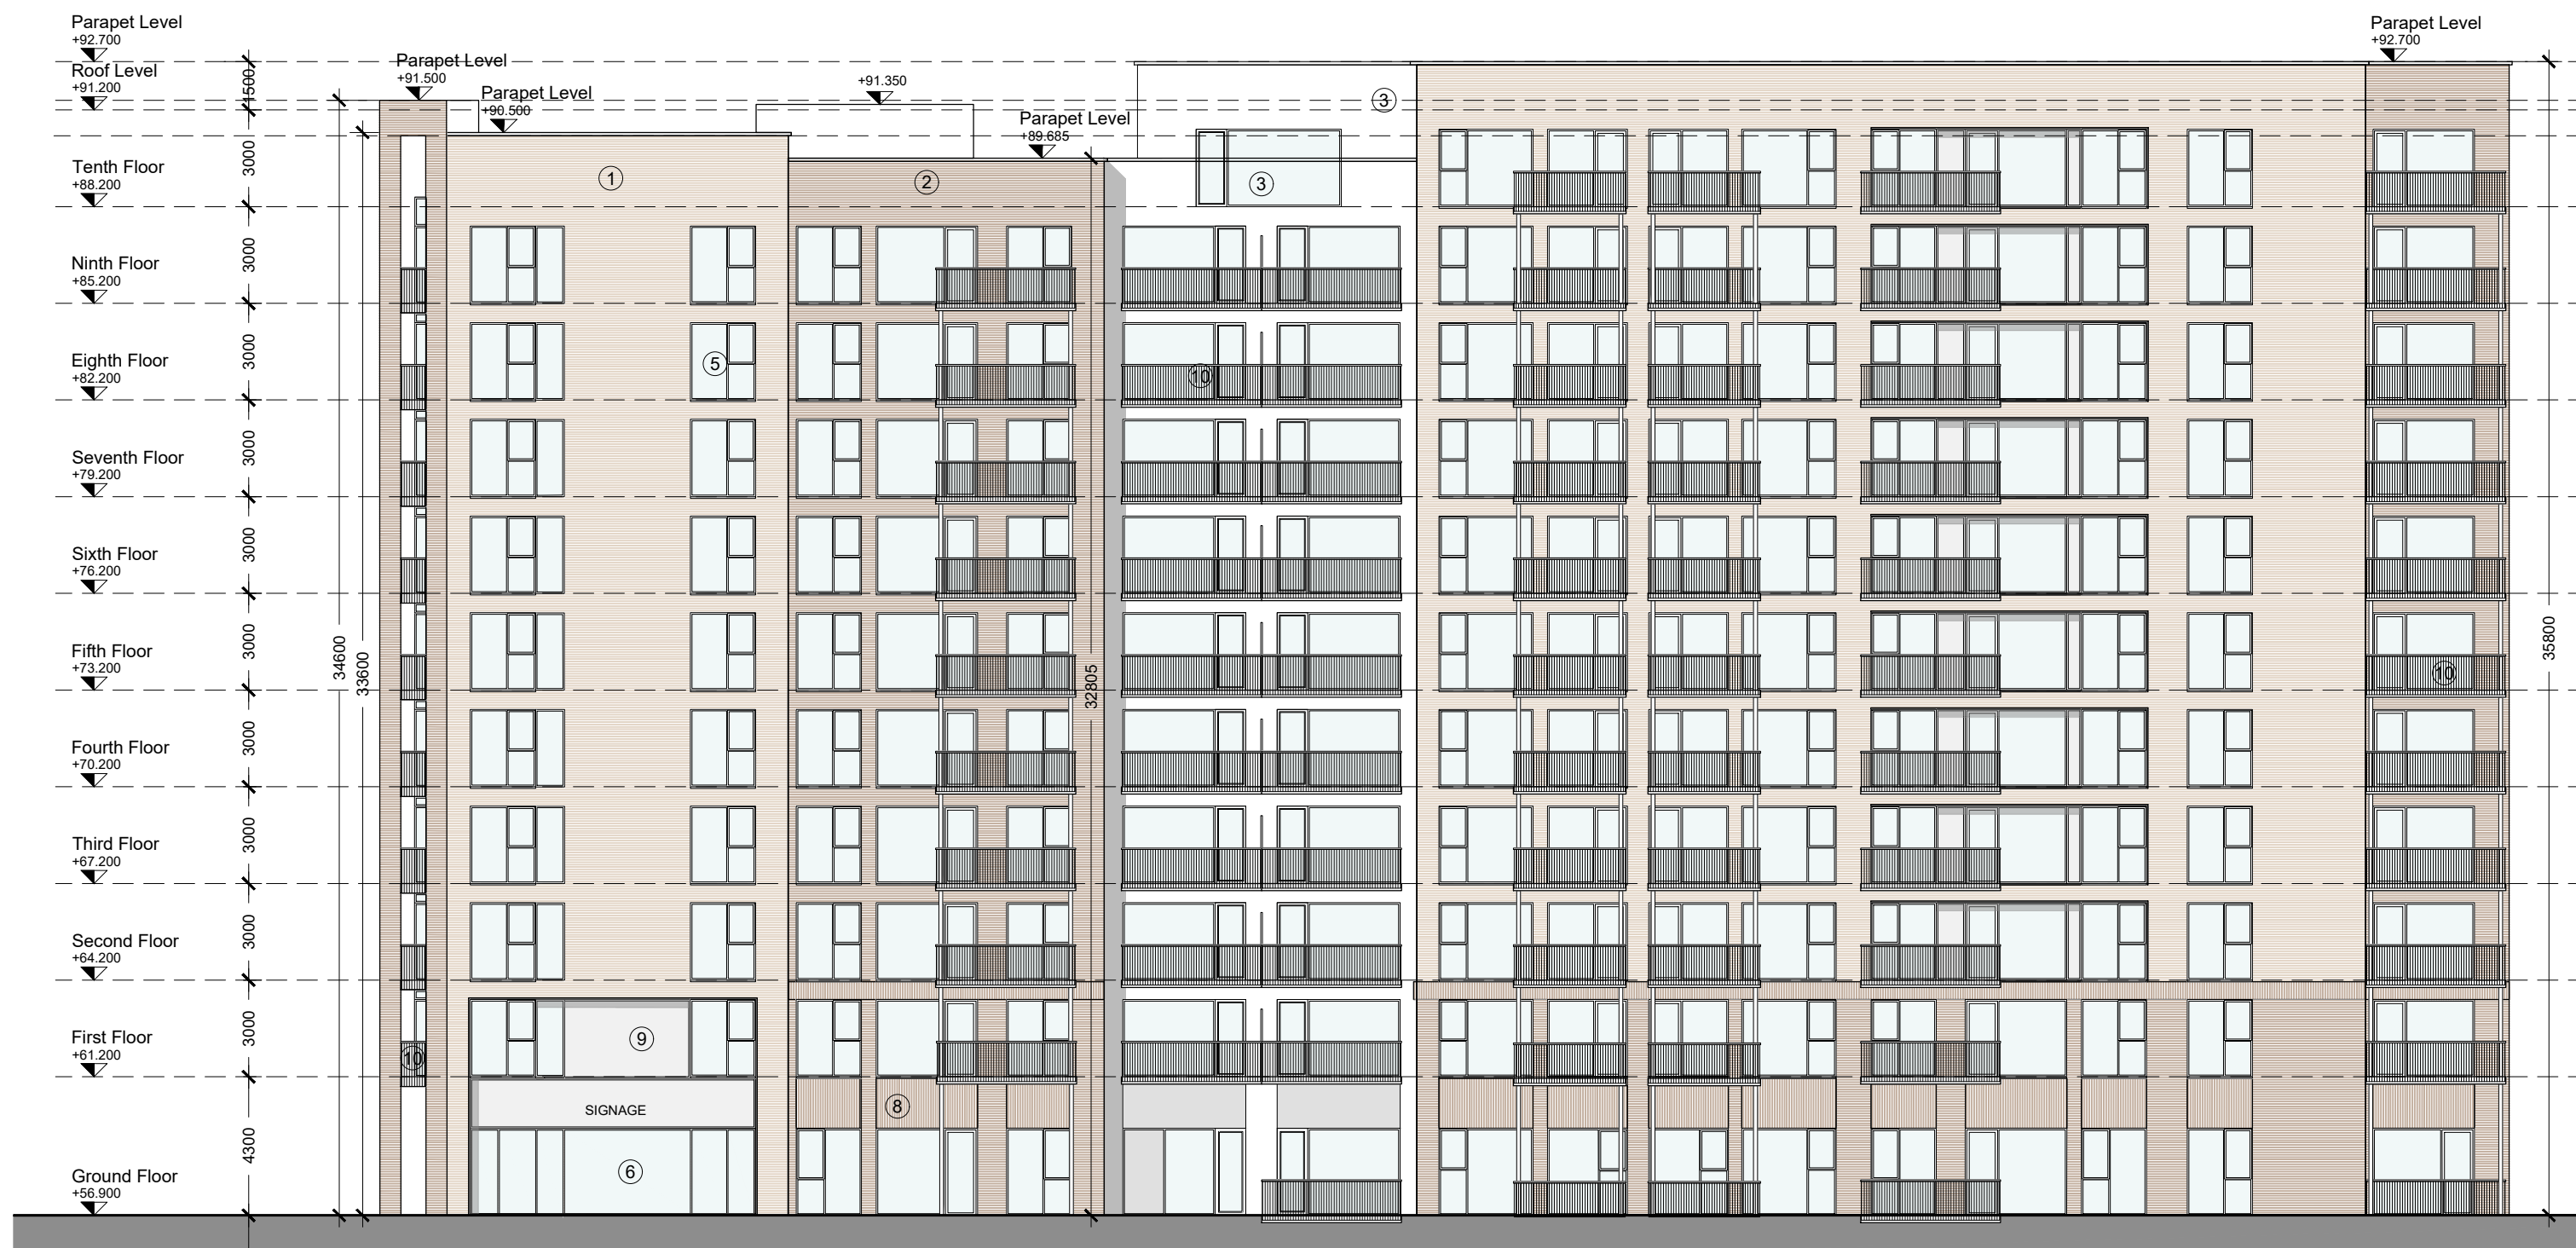


04 EAST ELEVATION
P4000 SCALE 1:200 @A1

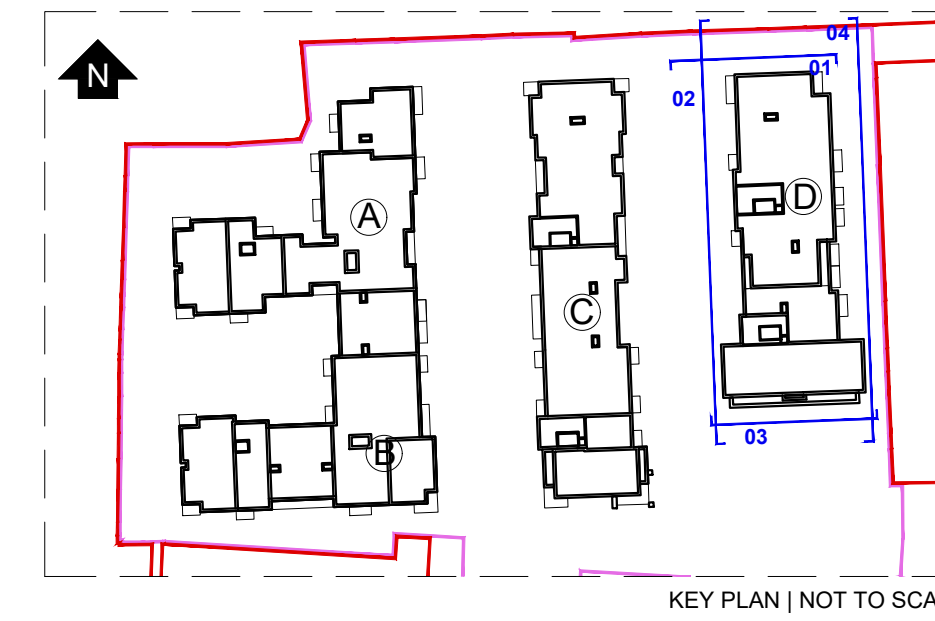

GENERAL NOTES			
1. COPYRIGHT RESERVED			
2. DO NOT SCALE DRAWING. USE FIGURED DIMENSIONS ONLY.			
3. ALL DISCREPANCIES TO BE REPORTED TO ARCHITECT			
4. THE CONTRACTOR IS RESPONSIBLE FOR CHECKING ALL LEVELS AND DIMENSIONS			
5. ALL STRUCTURE TO BE TO STRUCTURAL ENGINEERS DETAILS			
6. ALL MECH & ELEC SERVICES TO SERVICE ENGINEERS DETAILS			
7. ALL PROPRIETARY ITEMS TO BE INSTALLED IN ACCORDANCE WITH MANUFACTURERS INSTRUCTIONS			
8. CONTRACTOR IS RESPONSIBLE FOR THE COORDINATION OF STRUCTURE FINISHES AND SERVICES			
REV	DATE	DESCRIPTION	BY
A	03.08.21	Updated elevations according to the floor plans issued on the 29.07.21	LG
0	28.10.21	Issued for planning	LRIC
1	15.07.22	Issued for Planning - DRAFT	ICIMM
2	26.07.22	Issued for Planning - DRAFT	ICIMM
3	22.08.22	Issued for Planning	LRIC

MATERIAL LEGEND	
	1. Selected Cream Brick
	2. Selected Buff Brick
	3. Render
	4. Cement Board Cladding
	5. Double glazed windows/doors to selected colour
	6. Lightweight curtain walling system
	7. Double glazed aluminium frame windows to future selected colour with pressed metal cills, reveals and heads to match frames
	8. Brick detailing
	9. Opaque glass spandrel panel
	10. Balconies with steel guarding
	11. Matt Black flush fascia incorporating lighting fixtures and signage
	12. Canopy

- Site Boundary
- Development Area

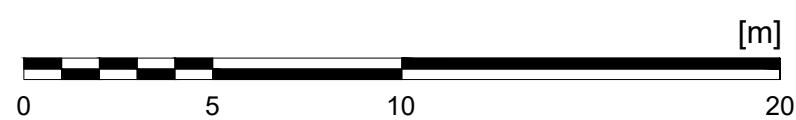




**JOHN FLEMING
ARCHITECTS**

THE TREE HOUSE, 17 RICHVIEW OFFICE PARK
CLONSKEAGH D14 XR82 IRELAND
T: (01) 6689888 E: info@jfa.ie W: www.jfa.ie

CLIENT
SERENDALE LIMITED

PROJECT
Omni Plaza SHD
Omni park shopping centre, Salford, Dublin 9

DRAWING
Proposed Block D
North, South, West & East Elevations

SCALE	JOB NO.
1:200 @ A1	1817
DRAWN BY	ICIMM/BLR
DATE	06.08.2021
DRAWING NUMBER	REVISION
OMN-JFA-ZZ-XX-DR-A-P4004	3

DRAWING LOCATION

DRAWING STATUS
PLANNING